


- ROOF PLAN NOTES:**
1. SEE DETAILS 2/24.0 FOR TYPICAL FRAMING AT FLOOR OPENINGS.
  2. = PRE-ENG WOOD TRUSSES @ 24" o.c. (2X6 @ 15" o.c. TYP. U.N.O.)
  3. = PRE-ENG JACK TRUSSES @ 24" o.c.
  4. KEY PLAN INDICATES THE NUMBER OF UNITS THAT WILL BE CONSTRUCTED FROM STRUCTURAL DRAWINGS.

- FLOOR TRUSS NOTES:**
1. SEE INTERIOR BEARING WALL LOCATIONS.
  2. TRUSSES SHALL BE DESIGNED FOR LOADS SHOWN BELOW
- |              |                     |
|--------------|---------------------|
| TOP CHORD    | DEAD LOAD.....28PSF |
|              | LIVE LOAD.....40PSF |
| BOTTOM CHORD | DEAD LOAD.....8PSF  |
|              | LIVE LOAD.....0PSF  |

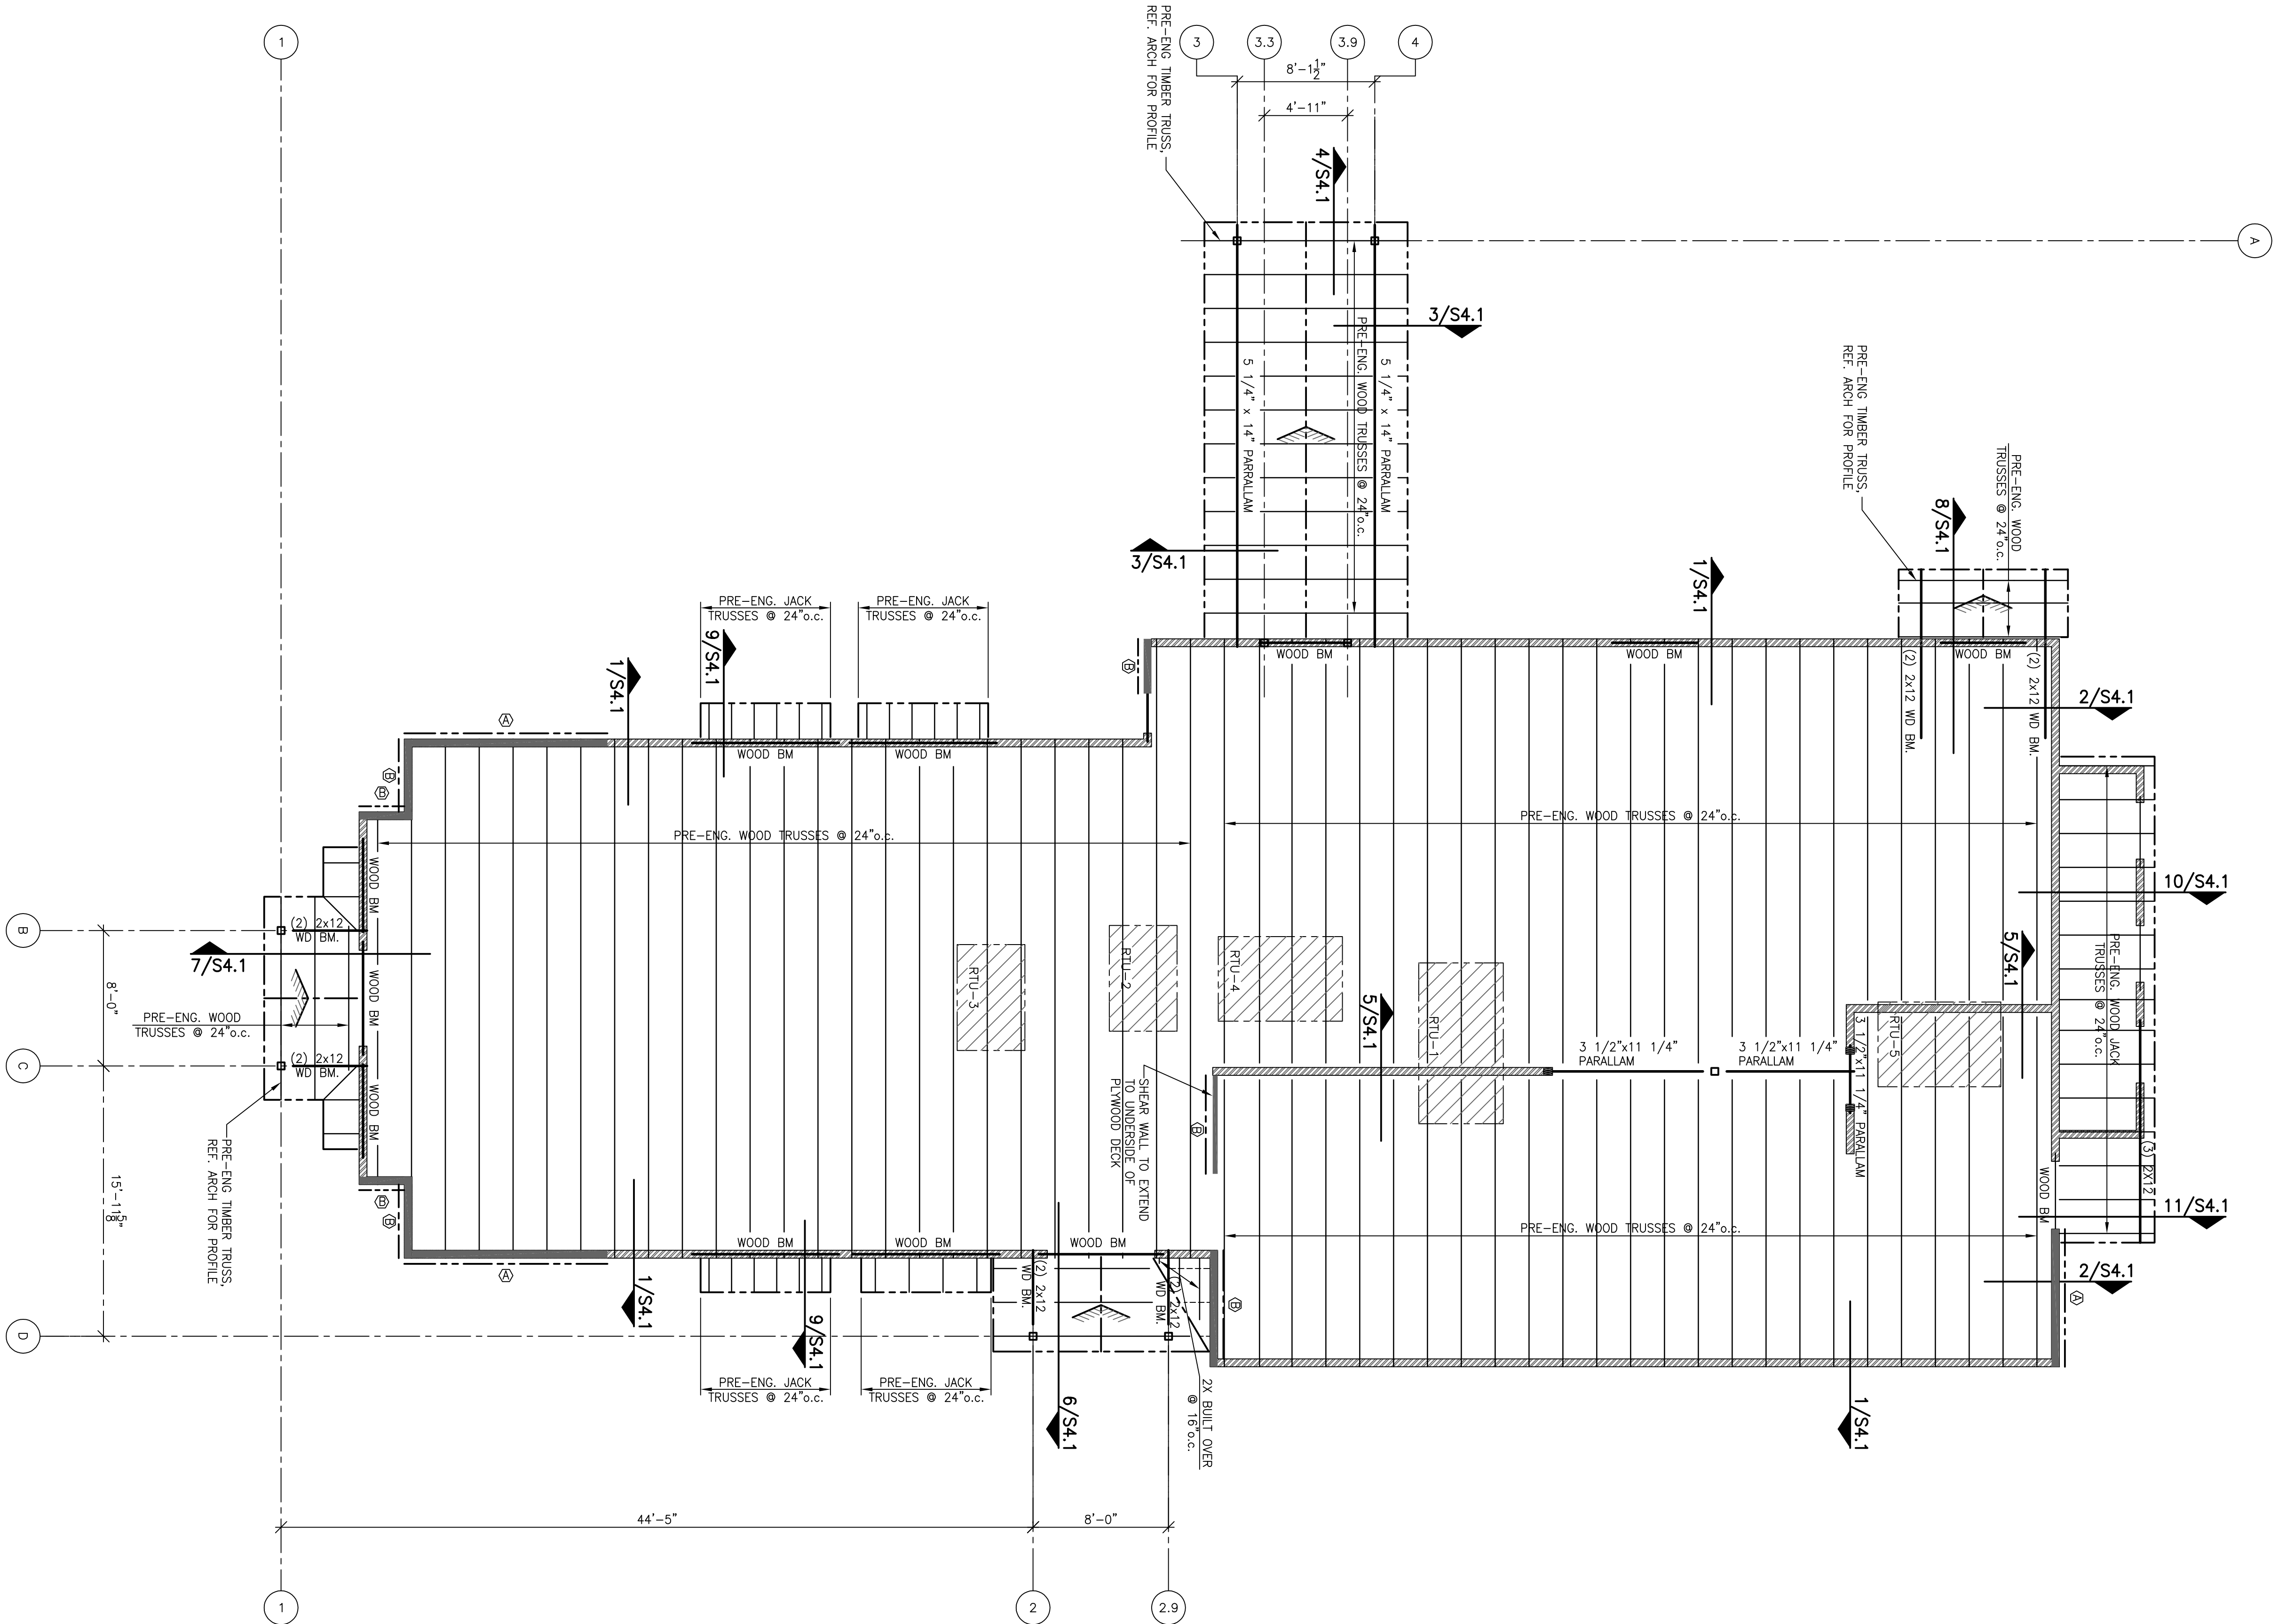

**1 ROOF FRAMING PLAN**  
SCALE: 3/76" = 1'-0"

<p>ENGINEER'S PROJECT NUMBER <b>142409</b></p> <p>DATE: 09/23/14</p> <p>SCALE</p> <p>REVISIONS</p>	<p><b>FRONTIER BURGERS</b></p> <p>PETRO CENTER/CROWNHILL @ 410 SAN ANTONIO, TEXAS 78254</p>	<p>Consulting Engineers, Inc. STRUCTURAL ENGINEERS 13300 OLD BLANCO ROAD, SUITE 326 SAN ANTONIO, TEXAS 78216 TEL: (210) 227-3847 www.alphaconsultingengineers.com</p>	<p>9-23-14</p>	<p><b>MORGAN SPEAR ASSOCIATES, INC.</b></p> <p>ARCHITECTS PLANNERS 225 S. CARANCAHUA STREET CORPUS CHRISTI, TEXAS 78401 (361) 883-5588 PHONE (361) 883-9204 FAX</p>
<p>SHEET NUMBER <b>S2.1</b></p> <p>SHEET 5 OF 8</p>				